



### **AMERICAN TOWER®**

ATC SITE NAME: ISLAND ATC SITE NUMBER: 300898

VERIZON SITE NAME: LAX ISLAND VERIZON SITE NUMBER: 124379

SITE ADDRESS: 537 N. FIGUEROA STREET

WILMINGTON, CA 90744



**LOCATION MAP** 

# VERIZON ANTENNA AMENDMENT DRAWINGS

| COMPLIANCE CODE   | PROJECT   | SUMMARY   | PROJECT DESCRIPTION   | _ /               | SHEET INDEX                    | (          |            |     |
|---|---|---|---|-------------------|--------------------------------|------------|------------|-----|
| ALL WORK SHALL BE PERFORMED AND MATERIALS INSTALLED IN ACCORDANCE WITH THE CURRENT EDITIONS OF THE        | SITE AD   |   | THE PROPOSED PROJECT INCL <mark>UDES MODIFYING GROUND BASED</mark> AND TOWER MOUNTED EQUIPMENT AS INDICATED PER BELOW:  | SHEET<br>NO:      | DESCRIPTION:                   | REV:       | DATE:      | BY: |
| FOLLOWING CODES AS ADOPTED BY THE LOCAL GOVERNMENT AUTHORITIES. NOTHING IN THESE PLANS IS TO              | 537 N. FIGUE  |   | TOWER WORK:   | G-001             | TITLE SHEET                    | A          | 10/18/2021 | SA  |
| BE CONSTRUED TO PERMIT WORK NOT CONFORMING TO THESE CODES.  | WILMINGTO<br>COUNTY: LC   | ,   | REMOVE (9) ANTENNA(s)  INSTALL (9) ANTENNA(s), (6) RRU(s), (2) OVP(s) AND (2) 1 5/8" HYBRID   | G-002             | GENERAL NOTES                  | A          | 10/18/2021 | SA  |
| 1. 2020 COUNTY OF LOS ANGELES BUILDING CODE (TITLE 26)  | GEOGRAPHIC (  |   | CABLE(s)  | C-101             | DETAILED SITE PLAN             | А          | 10/18/2021 | SA  |
| 2. 2020 COUNTY OF LOS ANGELES ELECTRICAL CODE (TITLE  | LATITUDE:   |   | EXISTING (12) ANTENNA(s), (6) RRU(s) (1) OVP, (6) 7/8" COAX CABLE,<br>AND (1) 1 5/8" HYBRID CABLE TO REMAIN   | C-201             | TOWER ELEVATION                | A          | 10/18/2021 | SA  |
| 27) 3. 2020 COUNTY OF LOS ANGELES PLUMBING CODE (TITLE  | LONGITUDE   |   | GROUND WORK:  | C-401             | ANTENNA INFORMATION & SCHEDULE | A          | 10/18/2021 | SA  |
| 28) 4. 2020 COUNTY OF LOS ANGELES MECHANICAL CODE (TITLE  | GROUND ELEVA  | ATION: 31' AMSL   | INSTALL (2) OVP(s)  | C-501             | CONSTRUCTION DETAILS           | A          | 10/18/2021 | SA  |
| 29)   |   |   | EXISTING (1) OVP TO REMAIN  | C-502             | EQUIPMENT DETAILS              | A          | 10/18/2021 | SA  |
| 5. 2020 COUNTY OF LOS ANGELES RESIDENTIAL CODE (TITLE 30)   |   |   | E-501   | GROUNDING DETAILS | A                              | 10/18/2021 | SA         |     |
| 6. 2020 COUNTY OF LOS ANGELES GREEN BUILDING<br>STANDARDS CODE (TITLE 31)                                 |   |   | PROJECT NOTES   | E-501             | GROUNDING DETAILS              | A          | 10/18/2021 | SA  |
| 7. 2020 COUNTY OF LOS ANGELES EXISTING BUILDING CODE (TITLE 33)   | PROJECT TEAM  | THE FACILITY IS UNMANNED.     A TECHNICIAN WILL VISIT THE SITE APPROXIMATELY ONCE   | R-601   | SUPPLEMENTAL      |                                |            |            |     |
| UTILITY COMPANIES  POWER COMPANY: SCE PHONE: (800) 684-8123  TELEPHONE COMPANY: SBC PHONE: (800) 310-2355 | TOWER OWNER:  AMERICAN TOWER  10 PRESIDENTIAL WAY WOBURN, MA 01801  PROPERTY OWNER: PN LL NO VENDOR 537 N. FIGUEROA ST WILMINGTON, CA 90744 | APPLICANT: VERIZON WIRELESS 15505 SAND CANYON AVE. BUILDING D, FIRST FLOOR IRVINE, CA 92618   | A MONTH FOR ROUTINE INSPECTION AND MAINTENANCE.  3. THE PROJECT WILL NOT RESULT IN ANY SIGNIFICANT LAND DISTURBANCE OR EFFECT OF STORM WATER DRAINAGE.  4. NO SANITARY SEWER, POTABLE WATER OR TRASH DISPOSAL IS REQUIRED.  5. HANDICAP ACCESS IS NOT REQUIRED.  6. THE PROJECT DEPICTED IN THESE PLANS QUALIFIES AS AN ELIGIBLE FACILITIES REQUEST ENTITLED TO EXPEDITED REVIEW UNDER 47 U.S.C. § 1455(A) AS A MODIFICATION OF AN EXISTING WIRELESS TOWER THAT INVOLVES THE COLLOCATION, REMOVAL, AND/OR REPLACEMENT OF TRANSMISSION EQUIPMENT THAT IS NOT A SUBSTANTIAL CHANGE UNDER CFR § 1.61000 (B)(7).  PROJECT LOCATION DIRECTIONS |                   |                                |            |            |     |
| Know what's below. Call before you dig.   |   | FROM ATC IRVINE OFFICE (19100 VON KARMAN, IRVINE, CA 92612) TAKE HWY 405N TO HWY 110S EXITING AT ANAHEIM ST. TURN LEFT ON ANAHEIM ST., THEN IMMEDIATE RIGHT TURN UNDER FREEWAY ONTO FIGUEROA ST. AND PROCEED SOUTH TO SITE ADDRESS. |   |                   |                                |            |            |     |



| REV.                | DESCRIPTION | BY  | DATE     |
|---------------------|-------------|-----|----------|
| A                   | PRELIM      | SA_ | 10/18/21 |
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ATC SITE NUMBER: 300898

ATC SITE NAME: ISLAND

VERIZON SITE NAME: LAX ISLAND

SITE ADDRESS: 537 N. FIGUEROA STREET WILMINGTON, CA 90744

SEAL



| П | DATE DRAWN:  | 10/18/21   |
|---|--------------|------------|
| П | ATC JOB NO:  | 13716831   |
| П | CUSTOMER ID: | LAX ISLAND |
| П | CUSTOMER #:  | 124379     |
|   |              |            |

TITLE SHEET

SHEET NUMBER:

G-001

Α

#### **GENERAL CONSTRUCTION NOTES:**

- OWNER FURNISHED MATERIALS, VERIZON "THE COMPANY" WILL PROVIDE AND THE CONTRACTOR WILL INSTALL
  - BTS EQUIPMENT FRAME (PLATFORM) AND ICEBRIDGE SHELTER (GROUND BUILD/CO-LOCATE ONLY)
  - B. AC/TELCO INTERFACE BOX (PPC)
  - C. ICE BRIDGE (CABLE TRAY WITH COVER) (GROUND BUILD/CO-LOCATE ONLY, GC TO FURNISH AND INSTALL FOR ROOFTOP INSTALLATION)
  - D. TOWERS, MONOPOLES
  - E. TOWER LIGHTING
  - F. GENERATORS & LIQUID PROPANE TANK
  - G. ANTENNA STANDARD BRACKETS, FRAMES AND PIPES FOR MOUNTING
  - H. ANTENNAS (INSTALLED BY OTHERS)
  - I. TRANSMISSION LINE
  - J. TRANSMISSION LINE JUMPERS
  - K. TRANSMISSION LINE CONNECTORS WITH WEATHERPROOFING KITS
  - L. TRANSMISSION LINE GROUND KITS
  - M. HANGERS
  - N. HOISTING GRIPS
  - O. BTS EQUIPMENT
- 2. THE CONTRACTOR IS RESPONSIBLE TO PROVIDE ALL OTHER MATERIALS FOR THE COMPLETE INSTALLATION OF THE SITE INCLUDING, BUT NOT LIMITED TO, SUCH MATERIALS AS FENCING, STRUCTURAL STEEL SUPPORTING SUB-FRAME FOR PLATFORM, ROOFING LABOR AND MATERIALS, GROUNDING RINGS, GROUNDING WIRES, COPPER-CLAD OR XIT CHEMICAL GROUND ROD(S), BUSS BARS, TRANSFORMERS AND DISCONNECT SWITCHES WHERE APPLICABLE, TEMPORARY ELECTRICAL POWER, CONDUIT, LANDSCAPING COMPOUND STONE, CRANES, CORE DRILLING, SLEEPERS AND RUBBER MATTING, REBAR, CONCRETE CAISSONS, PADS AND/OR AUGER MOUNTS, MISCELLANEOUS FASTENERS, CABLE TRAYS, NON-STANDARD ANTENNA FRAMES AND ALL OTHER MATERIAL AND LABOR REQUIRED TO COMPLETE THE JOB ACCORDING TO THE DRAWINGS AND SPECIFICATIONS. IT IS THE POSITION OF VERIZON TO APPLY FOR PERMITTING AND CONTRACTOR RESPONSIBLE FOR PICKUP AND PAYMENT OF REQUIRED PERMITS.
- ALL WORK SHALL CONFORM TO ALL CURRENT APPLICABLE FEDERAL, STATE, AND LOCAL CODES, INCLUDING ANSI/EIA/TIA-222, AND COMPLY WITH ATC CONSTRUCTION SPECIFICATIONS.
- 4. CONTRACTOR SHALL CONTACT LOCAL 811 FOR IDENTIFICATION OF UNDERGROUND
- 5. CONTRACTOR SHALL BE RESPONSIBLE FOR COORDINATING ALL REQUIRED
- ALL DIMENSIONS TO, OF, AND ON EXISTING BUILDINGS, DRAINAGE STRUCTURES, AND SITE IMPROVEMENTS SHALL BE VERIFIED IN FIELD BY CONTRACTOR WITH ALL DISCREPANCIES REPORTED TO THE ENGINEER.
- 7. DO NOT CHANGE SIZE OR SPACING OF STRUCTURAL ELEMENTS.
- DETAILS SHOWN ARE TYPICAL; SIMILAR DETAILS APPLY TO SIMILAR CONDITIONS UNLESS OTHERWISE NOTED.
- THESE DRAWINGS DO NOT INCLUDE NECESSARY COMPONENTS FOR CONSTRUCTION SAFETY WHICH SHALL BE THE SOLE RESPONSIBILITY OF THE CONTRACTOR.
- CONTRACTOR SHALL BRACE STRUCTURES UNTIL ALL STRUCTURAL ELEMENTS NEEDED FOR STABILITY ARE INSTALLED. THESE ELEMENTS ARE AS FOLLOWS: LATERAL BRACING, ANCHOR BOLTS. FTC.
- 11. CONTRACTOR SHALL DETERMINE EXACT LOCATION OF EXISTING UTILITIES, GROUNDS DRAINS, DRAIN PIPES, VENTS, ETC. BEFORE COMMENCING WORK.
- 12. INCORRECTLY FABRICATED, DAMAGED, OR OTHERWISE MISFITTING OR NONCONFORMING MATERIALS OR CONDITIONS SHALL BE REPORTED TO THE VERIZON REP PRIOR TO REMEDIAL OR CORRECTIVE ACTION. ANY SUCH REMEDIAL ACTION SHALL REQUIRE WRITTEN APPROVAL BY THE VERIZON REP PRIOR TO PROCEEDING.
- 13. EACH CONTRACTOR SHALL COOPERATE WITH THE VERIZON REP, AND COORDINATE HIS WORK WITH THE WORK OF OTHERS.
- 14. CONTRACTOR SHALL REPAIR ANY DAMAGE CAUSED BY CONSTRUCTION OF THIS PROJECT TO MATCH EXISTING PRE-CONSTRUCTION CONDITIONS TO THE SATISFACTION OF THE VERIZON CONSTRUCTION MANAGER
- 15. ALL CABLE/CONDUIT ENTRY/EXIT PORTS SHALL BE WEATHERPROOFED DURING INSTALLATION LISING A SILICONE SEALANT
- WHERE EXISTING CONDITIONS DO NOT MATCH THOSE SHOWN IN THIS PLAN SET, CONTRACTOR SHALL NOTIFY THE VERIZON REP AND ENGINEER OF RECORD IMMEDIATELY.
- 17. CONTRACTOR SHALL ENSURE ALL SUBCONTRACTORS ARE PROVIDED WITH A COMPLETE AND CURRENT SET OF DRAWINGS AND SPECIFICATIONS FOR THIS PROJECT.
- CONTRACTOR SHALL REMOVE ALL RUBBISH AND DEBRIS FROM THE SITE AT THE END OF EACH DAY.
- CONTRACTOR SHALL COORDINATE WORK SCHEDULE WITH AMERICAN TOWER CORPORATION (ATC). AND TAKE PRECAUTIONS TO MINIMIZE IMPACT AND DISRUPTION OF OTHER OCCUPANTS OF THE FACILITY.
- 20. CONTRACTOR SHALL FURNISH VERIZON AND AMERICAN TOWER CORPORATION (ATC) WITH A PDF MARKED UP AS-BUILT SET OF DRAWINGS UPON COMPLETION OF WORK.
- PRIOR TO SUBMISSION OF BID, CONTRACTOR SHALL COORDINATE WITH VERIZON REP TO DETERMINE WHAT, IF ANY, ITEMS WILL BE PROVIDED. ALL ITEMS NOT PROVIDED SHALL BE PROVIDED AND INSTALLED BY THE CONTRACTOR. CONTRACTOR WILL INSTALL ALL ITEMS PROVIDED.

- PRIOR TO SUBMISSION OF BID, CONTRACTOR SHALL COORDINATE WITH VERIZON REP
  TO DETERMINE IF ANY PERMITS WILL BE OBTAINED BY CONTRACTOR. ALL REQUIRED
  PERMITS NOT OBTAINED BY VERIZON MUST BE OBTAINED, AND PAID FOR, BY THE
  CONTRACTOR
- CONTRACTOR SHALL INSTALL ALL SITE SIGNAGE IN ACCORDANCE WITH VERIZON SPECIFICATIONS AND REQUIREMENTS.
- 24. CONTRACTOR SHALL SUBMIT ALL SHOP DRAWINGS TO VERIZON FOR REVIEW AND APPROVAL PRIOR TO FABRICATION.
- 25. ALL EQUIPMENT SHALL BE INSTALLED ACCORDING TO MANUFACTURER'S SPECIFICATIONS AND LOCATED ACCORDING TO VERIZON SPECIFICATIONS, AND AS SHOWN IN THESE PLANS.
- 26. THE CONTRACTOR SHALL SUPERVISE AND DIRECT THE PROJECT DESCRIBED HEREIN. THE CONTRACTOR SHALL BE SOLELLY RESPONSIBLE FOR ALL THE CONSTRUCTION MEANS, METHODS, TECHNIQUES, SEQUENCES AND PROCEDURES AND FOR COORDINATING ALL PORTIONS OF THE WORK UNDER THE CONTRACT.
- CONTRACTOR SHALL NOTIFY VERIZON REP A MINIMUM OF 48 HOURS IN ADVANCE OF POURING CONCRETE OR BACKFILLING ANY UNDERGROUND UTILITIES, FOUNDATIONS OR SEALING ANY WALL, FLOOR OR ROOF PENETRATIONS FOR ENGINEERING REVIEW AND APPROVAL
- 28. CONTRACTOR SHALL BE RESPONSIBLE FOR SITE SAFETY INCLUDING COMPLIANCE WITH ALL APPLICABLE OSHA STANDARDS AND RECOMMENDATIONS AND SHALL PROVIDE ALL NECESSARY SAFETY DEVICES INCLUDING PPE AND PPM AND CONSTRUCTION DEVICES SUCH AS WELDING AND FIRE PREVENTION, TEMPORARY SHORING, SCAFFOLDING, TRENCH BOXES/SLOPING, BARRIERS, ETC.
- 29. THE CONTRACTOR SHALL PROTECT AT HIS OWN EXPENSE, ALL EXISTING FACILITIES AND SUCH OF HIS NEW WORK LIABLE TO INJURY DURING THE CONSTRUCTION PERIOD. ANY DAMAGE CAUSED BY NEGLECT ON THE PART OF THIS CONTRACTOR OR HIS REPRESENTATIVES, OR BY THE ELEMENTS DUE TO NEGLECT ON THE PART OF THIS CONTRACTOR OR HIS REPRESENTATIVES, EITHER TO THE EXISTING WORK, OR TO HIS WORK OR THE WORK OF ANY OTHER CONTRACTOR, SHALL BE REPAIRED AT HIS EXPENSE TO THE OWNER'S SATISFACTION.
- 30. ALL WORK SHALL BE INSTALLED IN A FIRST CLASS, NEAT AND WORKMANLIKE MANNER BY MECHANICS SKILLED IN THE TRADE INVOLVED. THE QUALITY OF WORKMANSHIP SHALL BE SUBJECT TO THE APPROVAL OF THE VERIZON REP. ANY WORK FOUND BY THE VERIZON REP TO BE OF INFERIOR QUALITY AND/OR WORKMANSHIP SHALL BE REPLACED AND/OR REWORKED AT CONTRACTOR EXPENSE UNTIL APPROVAL IS OBTAINED.
- 31. IN ORDER TO ESTABLISH STANDARDS OF QUALITY AND PERFORMANCE, ALL TYPES OF MATERIALS LISTED HEREINAFTER BY MANUFACTURER'S NAMES AND/OR MANUFACTURER'S CATALOG NUMBER SHALL BE PROVIDED BY THESE MANUFACTURERS AS SPECIFIED.
- 32. VERIZON FURNISHED EQUIPMENT SHALL BE PICKED-UP AT THE VERIZON WAREHOUSE, NO LATER THAN 48HR AFTER BEING NOTIFIED INSURED, STORED, UNCRATE, PROTECTED AND INSTALLED BY THE CONTRACTOR WITH ALL APPURTENANCES REQUIRED TO PLACE THE EQUIPMENT IN OPERATION, READY FOR USE. THE CONTRACTOR SHALL BE RESPONSIBLE FOR THE EQUIPMENT AFTER PICKING IT UP.
- 33. VERIZON OR HIS ARCHITECT/ENGINEER RESERVES THE RIGHT TO REJECT ANY EQUIPMENT OR MATERIALS WHICH, IN HIS OWN OPINION ARE NOT IN COMPLIANCE WITH THE CONTRACT DOCUMENTS, EITHER BEFORE OR AFTER INSTALLATION AND THE EQUIPMENT SHALL BE REPLACED WITH EQUIPMENT CONFORMING TO THE REQUIREMENTS OF THE CONTRACT DOCUMENTS BY THE CONTRACTOR AT NO COST TO VERIZON OR THEIR ARCHITECT/ENGINEER.

## SPECIAL CONSTRUCTION ANTENNA INSTALLATION NOTES:

- 1. WORK INCLUDED:
  - A. ANTENNA AND COAXIAL CABLES ARE FURNISHED BY VERIZON UNDER A SEPARATE CONTRACT. THE CONTRACTOR SHALL ASSIST ANTENNA INSTALLATION CONTRACTOR IN TERMS OD COORDINATION AND SITE ACCESS. ERECTION SUBCONTRACTOR SHALL BE RESPONSIBLE FOR THE PROTECTION OF PERSONNEL AND
  - B. INSTALL ANTENNA AS INDICATE ON DRAWINGS AND VERIZON SPECIFICATIONS.
  - C. INSTALL GALVANIZED STEEL ANTENNA MOUNTS AS INDICATED ON DRAWINGS
  - D. INSTALL FURNISHED GALVANIZED STEEL OR ALUMINUM WAVEGUIDE.
  - E. CONTRACTOR SHALL PROVIDE FOUR (4) SETS OF SWEEP TESTS USING ANRITZU-PACKARD 8713B RF SCALAR NETWORK ANALYZER. SUBMIT FREQUENCY DOMAIN REFLECTOMETER(FDR) TESTS RESULTS TO THE PROJECT MANAGER. SWEEP TESTS SHALL BE AS PER ATTACHED RFS "MINIMUM FIELD TESTING RECOMMENDED FOR ANTENNA AND HELIAX COAXIAL CABLE SYSTEMS" DATED 10/5/93. TESTING SHALL BE PERFORMED BY AN INDEPENDENT TESTING SERVICE AND BE BOUND AND SUBMITTED WITHIN ONE WEEK OF WORK COMPLETION.
  - F. INSTALL COAXIAL CABLES AND TERMINATING BETWEEN ANTENNAS AND EQUIPMENT PER MANUFACTURER'S RECOMMENDATIONS. WEATHERPROOF ALL CONNECTIONS BETWEEN THE ANTENNA AND EQUIPMENT PER MANUFACTURER'S REQUIREMENTS. TERMINATE ALL COAXIAL CABLE THREE (3) FEET IN EXCESS OF ENTRY PORT LOCATION UNLESS OTHERWISE STATED.
  - G. ANTENNA AND COAXIAL CABLE GROUNDING:
- ALL EXTERIOR #6 GREED GROUND WIRE "DAISY CHAIN" CONNECTIONS ARE TO BE WEATHER SEALED WITH RFS CONNECTORS/SPLICE WEATHERPROOFING KIT #221213 OR FOLIAL
- ALL COAXIAL CABLE GROUNDING KITS ARE TO BE INSTALLED ON STRAIGHT RUNS OF COAXIAL CABLE (NOT WITHIN BENDS)



ALL DISCREPANCIES FROM WHAT IS SHOWN ON THESE
CONSTRUCTION DRAWINGS SHALL BE COMMUNICATED TO ATC
ENGINEERING IMMEDIATELY FOR CORRECTION OR RE-DESIGN.
FAILURE TO COMMUNICATE DIRECTLY WITH ATC ENGINEERING OR
ANY CHANGES FROM THE DESIGN CONDUCTED WITHOUT PRIOR
APPROVAL FROM ATC ENGINEERING SHALL BE THE SOLE
RESPONSIBILITY OF THE GENERAL CONTRACTOR.



| REV. DESCRIPTION    | BY | DATE     |
|---------------------|----|----------|
| A PRELIM            | SA | 10/18/21 |
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|                     |    |          |

ATC SITE NUMBER: 300898

ATC SITE NAME:

VERIZON SITE NAME:

LAX ISLAND

SITE ADDRESS: 537 N. FIGUEROA STREET WILMINGTON, CA 90744

SEAL






DATE DRAWN: 10/18/21
ATC JOB NO: 13716831
CUSTOMER ID: LAX ISLAND
CUSTOMER #: 124379

**GENERAL NOTES** 

SHEET NUMBER:

G-002

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### LEGEND 8 GROUNDING TEST WELL AUTOMATIC TRANSFER SWITCH ATS В BOLLARD CELL SITE CABINET CSC DISCONNECT ELECTRICAL Е FIBER GEN GENERATOR GENERATOR RECEPTACAL G HH, V HAND HOLE, VAULT ΙB ICE BRIDGE KENTROX BOX LIGHTING CONTROL LC M METER PB PULL BOX PP POWER POLE TELCO TRN TRANSFORMER CHAINLINK FENCE WALLS

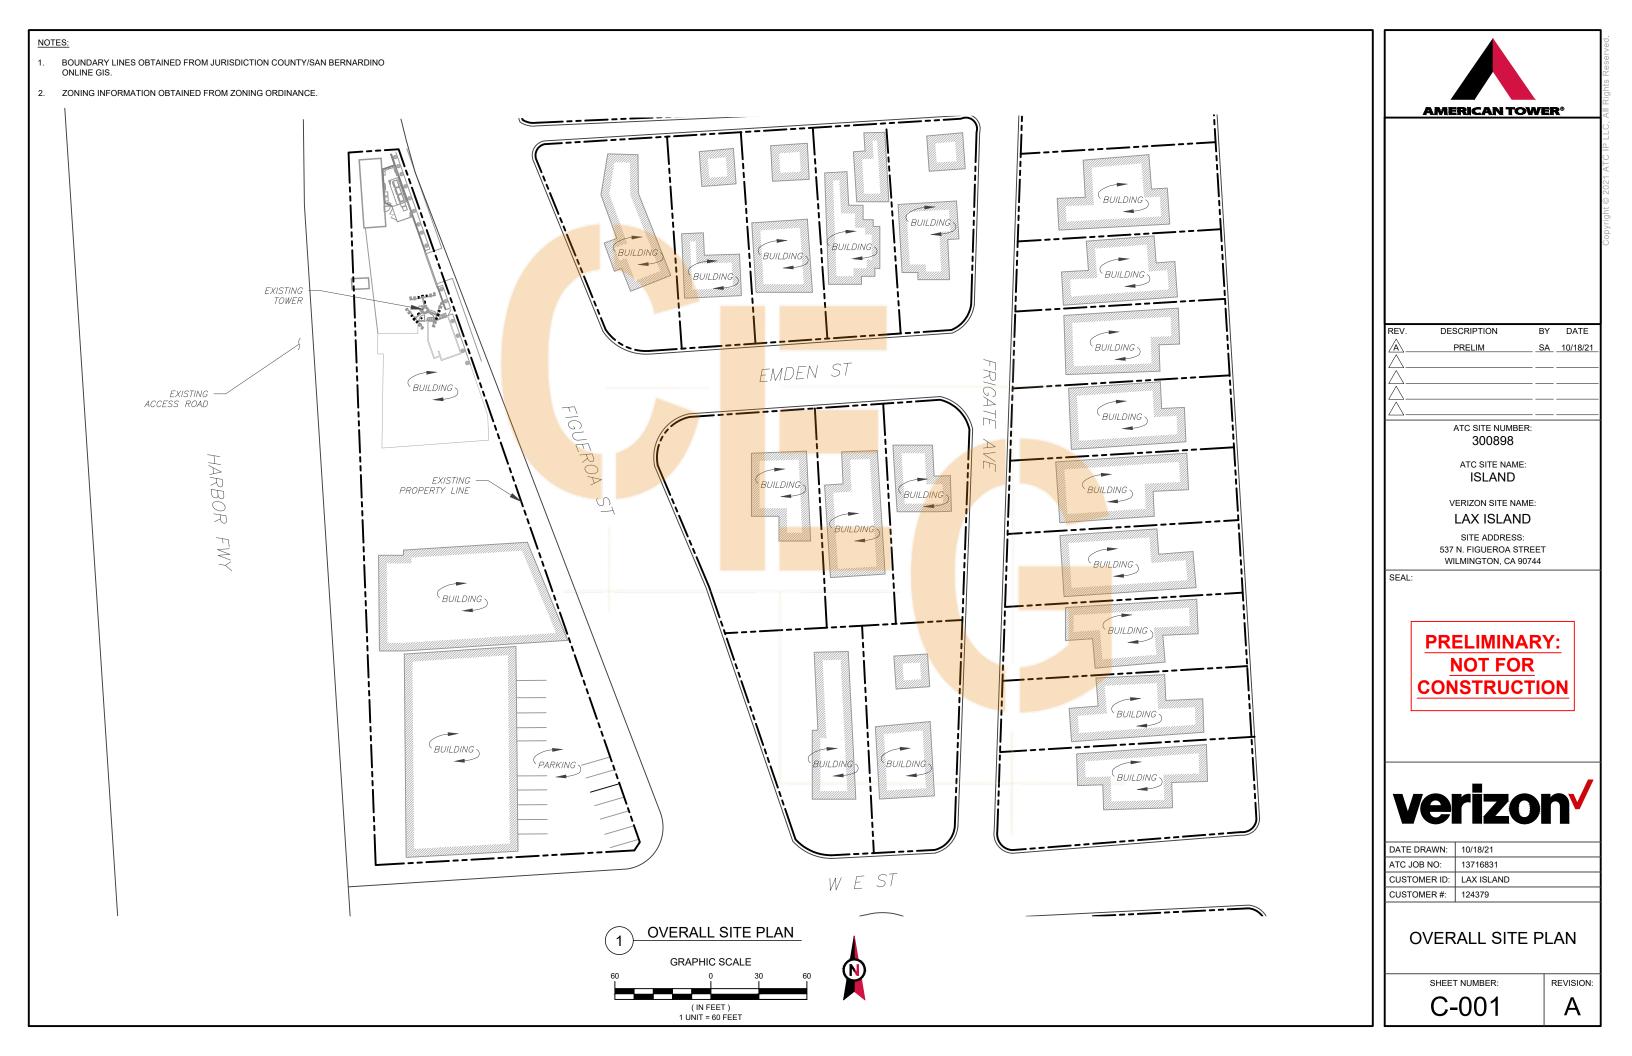AS SPECIFIED BY CABLE MANUFACTURER.


### SITE PLAN NOTES:

- 1. THIS SITE PLAN REPRESENTS THE BEST PRESENT KNOWLEDGE AVAILABLE TO THE ENGINEER AT THE TIME OF THIS DESIGN. THE CONTRACTOR SHALL VISIT THE SITE PRIOR TO CONSTRUCTION AND VERIFY ALL EXISTING CONDITIONS RELATED TO THE SCOPE OF WORK FOR THIS PROJECT.
- ICE BRIDGE, CABLE LADDER, COAX PORT, AND COAX CABLE ARE SHOWN FOR REFERENCE ONLY. CONTRACTOR SHALL CONFIRM THE EXACT LOCATION OF ALL PROPOSED AND EXISTING EQUIPMENT AND STRUCTURES DEPICTED ON THIS PLAN. BEFORE UTILIZING EXISTING CABLE SUPPORTS, COAX PORTS, INSTALLING NEW PORTS OR ANY OTHER EQUIPMENT, CONTRACTOR SHALL VERIFY ALL ASPECTS OF THE COMPONENTS MEET THE ATC SPECIFICATIONS.


20'-0" ACCESS ROAD

10' IN LENGTH

3. THIS PROJECT INCLUDES NO INSTALL OR MODIFICATION AT GRADE.

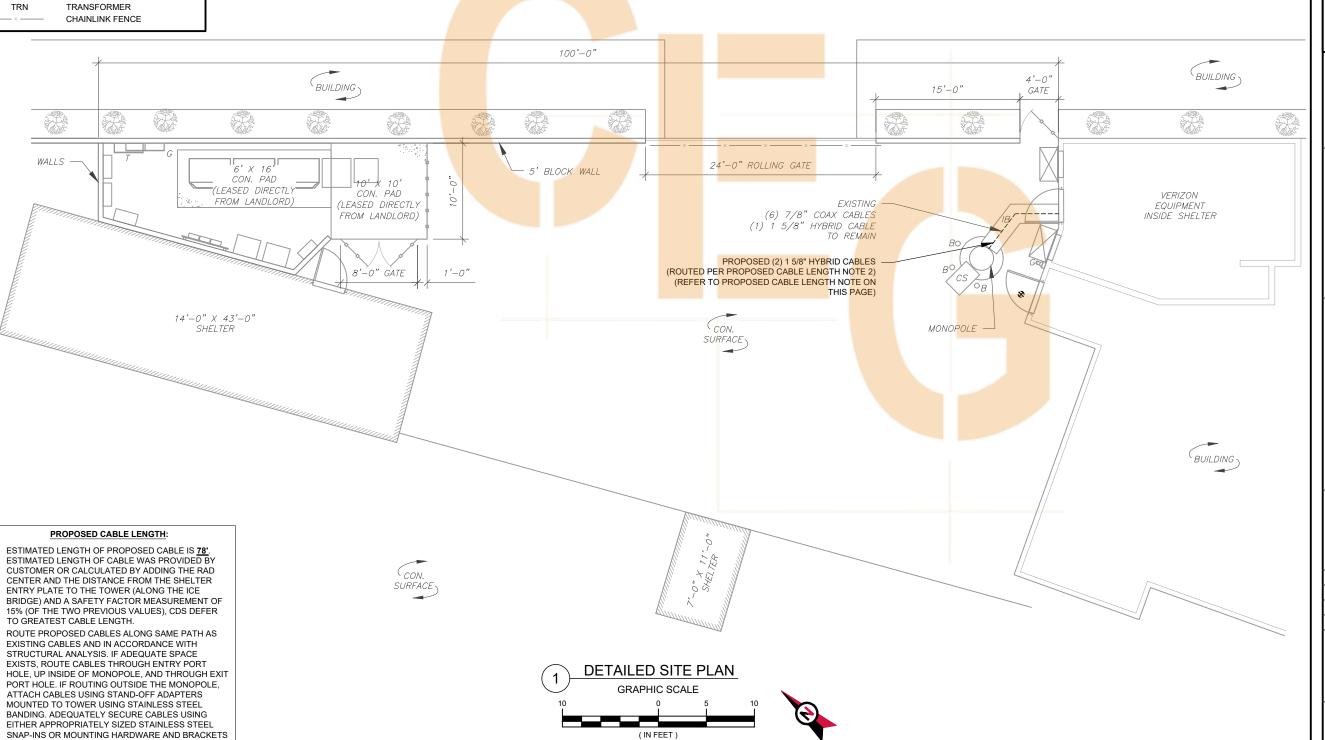

1 UNIT = 10 FEET

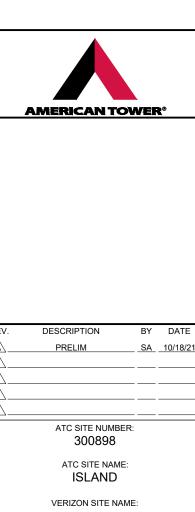

LAX ISLAND

SITE ADDRESS: 537 N. FIGUEROA STREET WILMINGTON, CA 90744

SEAL

PRELIMINARY:
NOT FOR
CONSTRUCTION



 DATE DRAWN:
 10/18/21

 ATC JOB NO:
 13716831


 CUSTOMER ID:
 LAX ISLAND


 CUSTOMER #:
 124379

DETAILED SITE PLAN

SHEET NUMBER:

C-101

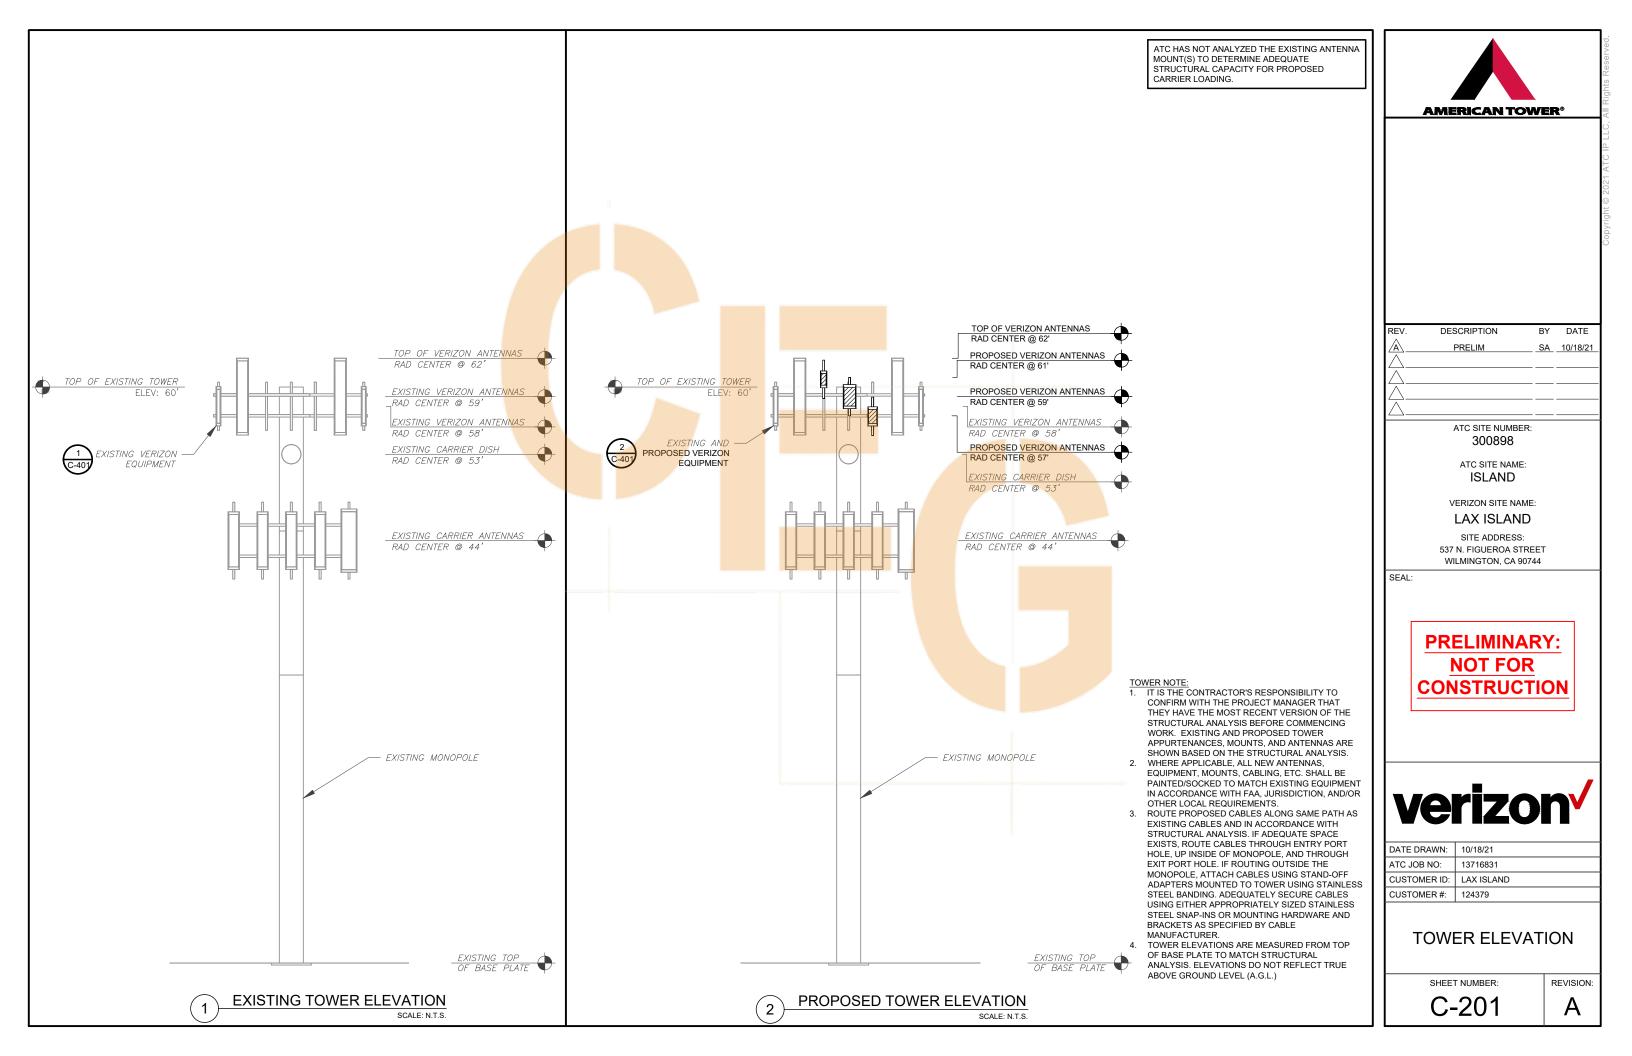


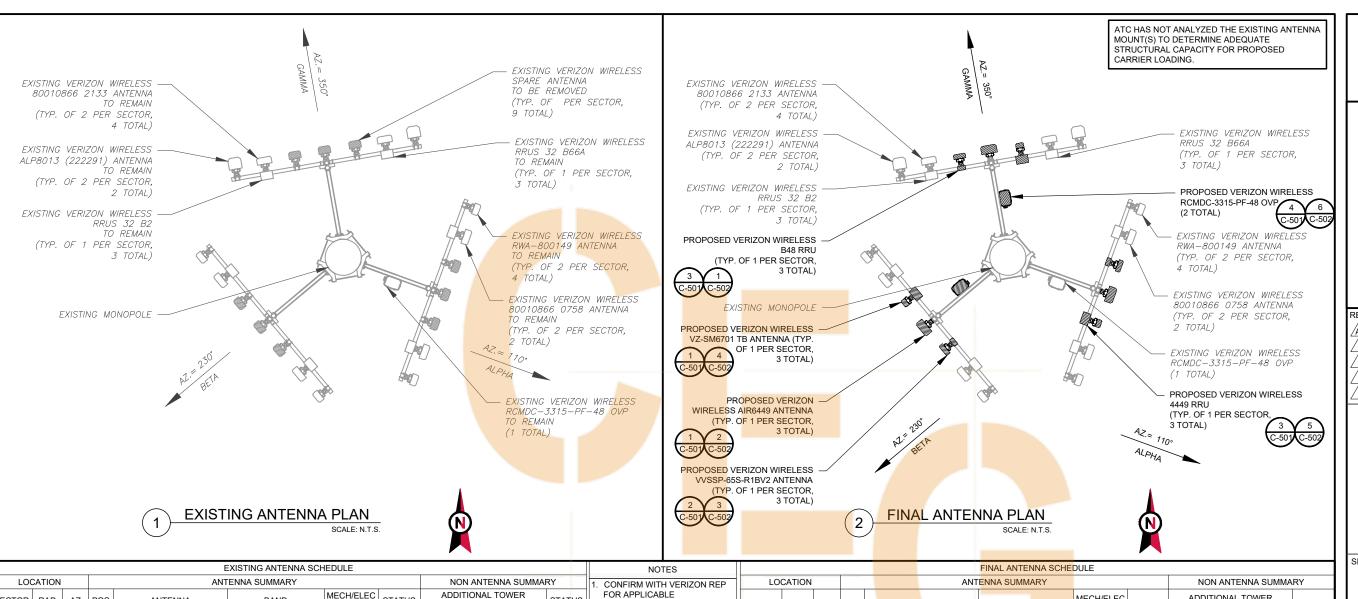

|       |       |      |           | EX               | ISTING ANTENNA S | SCHEDULE            |        |                                    |        | NOTES   |         |            |          |                               | FINAL ANTENNA SCH | HEDULE           |                                    |          |
|-------|-------|------|-----------|------------------|------------------|---------------------|--------|------------------------------------|--------|---|---------|------------|----------|-------------------------------|-------------------|------------------|------------------------------------|----------|
| LOC   | ATION |      |           | ANTE             | NNA SUMMARY      |                     |        | NON ANTENNA SUMM                   | ARY    | CONFIRM WITH VERIZON REP                            | LO      | CATION     |          | ANT                           | ENNA SUMMARY      |                  | NON ANTENNA SUMM                   | //ARY    |
| ECTOR | RAD   | ΑZ   | POS       | ANTENNA          | BAND             | MECH/ELEC<br>D-TILT | STATUS | ADDITIONAL TOWER MOUNTED EQUIPMENT | STATUS | FOR APPLICABLE UPDATES/REVISIONS AND                | SECTOR  | RAD A      | z Pos    | ANTENNA                       | BAND              | MECH/ELEC STATUS | ADDITIONAL TOWER MOUNTED EQUIPMENT | STATUS   |
|       | 58'   |      | A1        | RWA-800149       | CDMA             | _                   | RMN    | _                                  | _      | MOST RECENT RFDS FOR NSN CONFIGURATION (CONFIG). GC |         | 58'        | A1       | RWA-800149                    | CDMA              | - RMN            | _                                  | _        |
|       |       |      | A2        | 80010866 0758    | LTE/AWS          | _                   | RMN    | RRUS32 B2                          | RMN    | TO CAP ALL UNUSED PORTS. 2. CONFIRM SPACING OF      |         | 59'        | A2       | 80010866 0758                 | LTE/AWS           | - RMN            | RRUS32 B2                          | RMN      |
|       |       |      | A3        | SPARE            | _                | _                   | RMV    | _                                  | _      | PROPOSED EQUIP DOES NOT                             |         | 57'        | A3       | VVSSP-65S-R1BV2               | CBRS              | - ADD            | B48 RRU                            | ADD      |
| ALPHA | 59'   | 110° | A4        | SPARE            | _                | _                   | RMV    | -                                  | -      | CAUSE TOWER CONFLICTS NOR IMPEDE TOWER CLIMBING     | ALPHA   | 59' 11     |          | AIR6449                       | C-BAND            | - ADD            | AIR6449 RRU                        | ADD      |
|       |       |      | A5        | SPARE            | _                | _                   | RMV    | -                                  | _      | PEGS.   | ALITIA  | 61'        | A5       | VZ-SM6701 TB                  | C-BAND            | - ADD            | AINO449 NINO                       | -        |
|       |       |      | A6        | 80010866 0758    | LTE/AWS          | _                   | RMN    | RRUS32 B66A                        | RMN    |   | 1       | 59'        | A6       | 80010866 0758                 | LTE/AWS           | - RMN            | RRUS32 B66A                        | RMN      |
|       | 58'   |      | A7        | RWA-800149       | CDMA             | _                   | RMN    | _                                  | -      | STATUS ABBREVIATIONS                                | ]       | 58'        | A7       | RWA-800149                    | CDMA              | - RMN            | TITOGOZ BOOA                       | -        |
|       | 58'   |      | B1        | RWA-800149       | CDMA             | _                   | RMN    | _                                  | _      | RMV: TO BE REMOVED                                  |         | 58'        | B1       | RWA-800149                    | CDMA              | - RMN            | -                                  |          |
|       |       |      | B2        | 80010866 2133    | LTE/AWS          | _                   | RMN    | RRUS32 B2                          | RMN    | RMV. TO BE REMOVED  RMN: TO REMAIN                  |         | 59'        | B2       | 80010866 2133                 | LTE/AWS           | - RMN            | RRUS32 B2                          | RMN      |
|       |       |      | B3        | SPARE            | _                | _                   | RMV    | _                                  | _      | REL: TO BE RELOCATED<br>ADD: TO BE ADDED            |         | 57'        | B3       | VVSSP-65S-R1BV2               | CBRS              | - ADD            | B48 RRU                            | ADD      |
| BETA  | 59'   | 230° | · B4      | SPARE            | _                | _                   | RMV    | _                                  | _      | ADD. TO BE ADDED                                    | BETA    | 59' 23     |          | AIR6449                       | C-BAND            | - ADD            | AIR6449 RRU                        | ADD      |
|       |       |      | B5        | SPARE            | _                | _                   | RMV    | _                                  | _      |   | BEIA    | 61'        | B5       | VZ-SM6701 TB                  | C-BAND            | - ADD            | AIR0449 RRU                        |          |
|       |       |      | B6        | 80010866 2133    | LTE/AWS          | _                   | RMN    | RRUS32 B66A                        | RMN    | CABLE LENGTHS FOR JUMPERS                           | 1       | 59'        | B6       | 80010866 2133                 | LTE/AWS           | - ADD            | -<br>RRUS32 B66A                   | -<br>RMN |
|       | 58'   |      | B7        | RWA-800149       | CDMA             | _                   | RMN    | _                                  | _      | JUNCTION BOX TO RRU: 15'                            |         | 58'        | B7       | RWA-800149                    | CDMA              | - RMN            | KK0332 B00A                        | FIVIN    |
|       | 58'   |      | C1        | ALP8013 (222291) | CDMA             | _                   | RMN    | _                                  | _      | RRU TO ANTENNA: 10'                                 |         | 58'        | C1       | ALP8013 (222291)              | CDMA              | - RMN            | -                                  |          |
|       |       |      | C2        | 80010866 2133    | LTE/AWS          | _                   | RMN    | RRUS32 B2                          | RMN    |   | '       | 59'        | C2       | 80010866 2133                 | LTE/AWS           | - RMN            | RRUS32 B2                          | -<br>RMN |
|       |       |      | C3        | SPARE            |                  | _                   | RMV    | _                                  | _      |   |         | 57'        | C2       | VVSSP-65S-R1BV2               | CBRS              | - RIVIN          | B48 RRU                            | ADD      |
| GAMMA | 59'   | 350° | . C4      | SPARE            | _                | _                   | RMV    | _                                  | _      |   | GAMMA   |            |          |                               | -                 |                  |                                    |          |
|       |       |      | C5        | SPARE            |                  | _                   | RMV    |                                    | _      |   | GAININA |            |          | AIR6449                       | C-BAND            | - ADD            | AIR6449 RRU                        | ADD      |
|       |       |      | C6        | 80010866 2133    | LTE/AWS          | _                   | RMN    | RRUS32 B66A                        | RMN    |   |         | 61'<br>59' | C5<br>C6 | VZ-SM6701 TB<br>80010866 2133 | C-BAND<br>LTE/AWS | - ADD<br>- RMN   | -<br>RRUS32 B66A                   | -<br>RMN |
| ŀ     | 58'   |      | <i>G7</i> | ALP8013 (222291) | CDMA             | _                   | RMN    |                                    | -      |   |         | 58'        | C6       | ALP8013 (222291)              | CDMA              | - RMN            | KKU532 B00A                        | KIVIN    |

| EXISTING FIBER DISTRIBUTION | OVP BOX | EXIS     | TING CABLING SUI | MMARY  |                       |
|-----------------------------|---------|----------|------------------|--------|-----------------------|
| MODEL NUMBER STATUS         |         | COAX     | HYBRID           | STATUS | 3 EQUIPMENT SCHEDULES |
| RCMDC-3315-PF-48            | RMN     | (6) 7/8" | (1) 1 5/8"       | RMN    | •                     |

| FINAL FIBER DISTRIBUTION / OVI | FINAL CABLING SUMMARY |          |            |        |   |
|--------------------------------|-----------------------|----------|------------|--------|---|
| MODEL NUMBER                   | STATUS                | COAX     | HYBRID     | STATUS | П |
| RCMDC-3315-PF-48               | RMN                   | (6) 7/8" | (1) 1 5/8" | RMN    | Н |
| (2) RCMDC-3315-PF-48           | ADD                   | =        | (2) 1 5/8" | ADD    | Н |

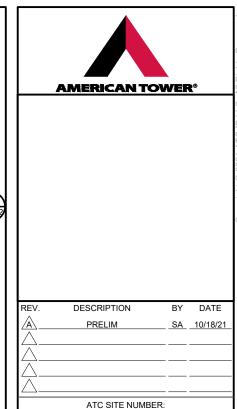

300898

ATC SITE NAME: ISLAND

VERIZON SITE NAME: LAX ISLAND

SITE ADDRESS: 537 N. FIGUEROA STREET WILMINGTON, CA 90744






| DATE DRAWN:  | 10/18/21   |
|--------------|------------|
| ATC JOB NO:  | 13716831   |
| CUSTOMER ID: | LAX ISLAND |
| CUSTOMER #:  | 124379     |
|              |            |

ANTENNA INFORMATION & SCHEDULE

SHEET NUMBER:

C-401

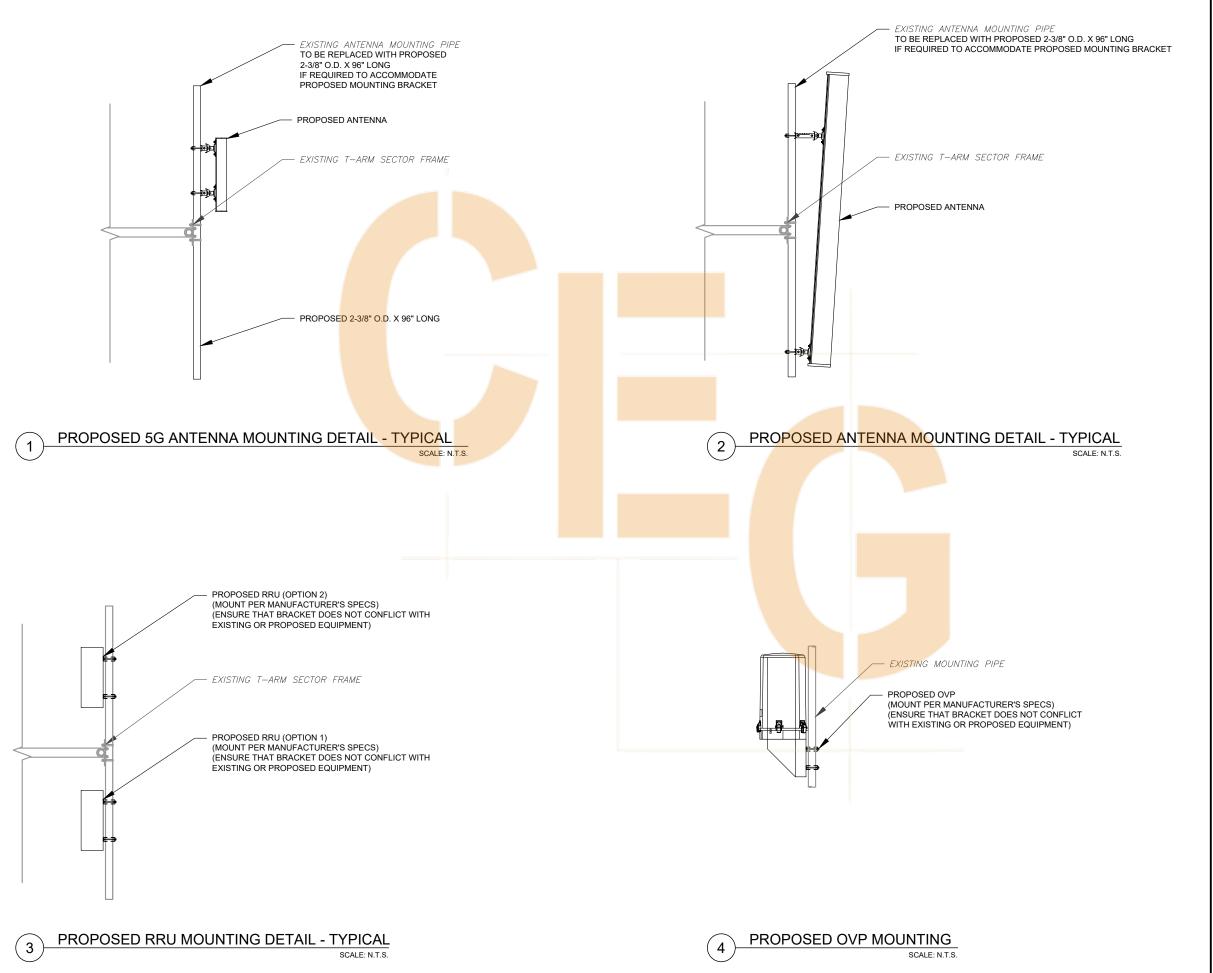

AMERICAN TOWER®

ATC SITE NUMBER: 300898

ATC SITE NAME: ISLAND

VERIZON SITE NAME:

LAX ISLAND

SITE ADDRESS: 537 N. FIGUEROA STREET WILMINGTON, CA 90744

SEAL

PRELIMINARY:
NOT FOR
CONSTRUCTION





DATE DRAWN: 10/18/21
ATC JOB NO: 13716831
CUSTOMER ID: LAX ISLAND
CUSTOMER #: 124379

CONSTRUCTION DETAILS


SHEET NUMBER:

C-501

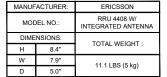

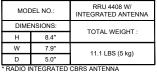


FRONT VIEW

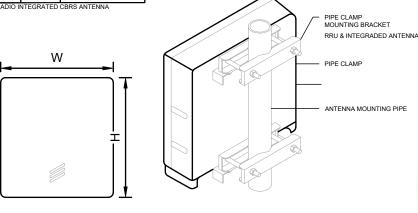

ISO VIEW

| ERICSSON<br>AIR6449 |           |  |  |  |  |  |
|---------------------|-----------|--|--|--|--|--|
| HEIGHT (H)          | 30.4"     |  |  |  |  |  |
| WIDTH (W)           | 15.9"     |  |  |  |  |  |
| DEPTH (D)           | 8.1"      |  |  |  |  |  |
| WEIGHT              | 81.6 LBS. |  |  |  |  |  |

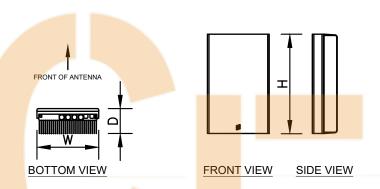

PROPOSED KRE ANTENNA DETAIL


SCALE: N.T.S.

PROPOSED AIR6449 ANTENNA DETAIL

PROPOSED VVSSP-65S-R1BV2 ANTENNA DETAIL

DUAL BAND RADIO
4449: B13 + B5 4TX 4RX PER BAND WITHOUT PIM-C
8843: B2 + B66A 4TX 4RX PER BAND WITHOUT PIM-C

- > 4449: 4 antenna ports, 4TX/4RX for 2 bands with common RF ports
- > 8843: 8 antenna ports, 4TX/4RX for 2 bands with separate
- Up to 320W RF power shared between 2 bands
  - Examples 4449:
    - 4x40W on each band or
    - » 2x60W each band on two high-power RF ports
  - Examples 8843:
    - # 4x40W on each band or
    - 4x20W on Band 2 and 4x60W on Band 66A
    - > 2x60W on Band 2 and 2x80W on Band 66A
- Carrier Capacity:
  - . 4449: Up to 24 carrier and up to 10+25 MHZ OBW for LTE
  - 8843: Up to 24 carrier and up to 60+70 MHZ OBW for LTE
- > 2x 10Gbps CPRI

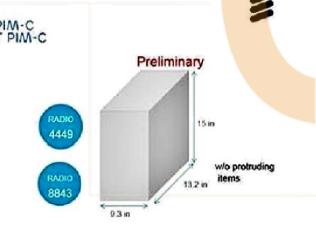

| Radio 4449 - B135 B5 | Height   | Width    | Depth    | Weight    |  |
|----------------------|----------|----------|----------|-----------|--|
| wo protruding items  | 15 in    | 13.2 ln  | 9.3 to   | 70 tos    |  |
|                      | (380 mm) | (335 mm) | (235 mm) | (31.8 Kg) |  |

Shall not exceed dimensions

PROPOSED VZ-SM6701 TB ANTENNA DETAIL

PROPOSED 4449 RRU DETAIL

SCALE: N.T.S.

PROPOSED RCMDC-3315-PF-48 OVP OVP DETAIL



| DESCRIPTION | BY  | DATE     |
|-------------|-----|----------|
| PRELIM      | SA_ | 10/18/21 |
|             |     |          |
|             |     |          |
|             |     |          |
|             |     |          |
|             |     |          |

ATC SITE NUMBER: 300898

ATC SITE NAME: ISLAND

VERIZON SITE NAME:

LAX ISLAND

SITE ADDRESS: 537 N. FIGUEROA STREET WILMINGTON, CA 90744







|  | Ш |              |            |
|--|---|--------------|------------|
|  | П | DATE DRAWN:  | 10/18/21   |
|  | П | ATC JOB NO:  | 13716831   |
|  |   | CUSTOMER ID: | LAX ISLAND |
|  | П | CUSTOMER #:  | 124379     |
|  |   |              |            |

**EQUIPMENT DETAILS** 

SHEET NUMBER:

C-502

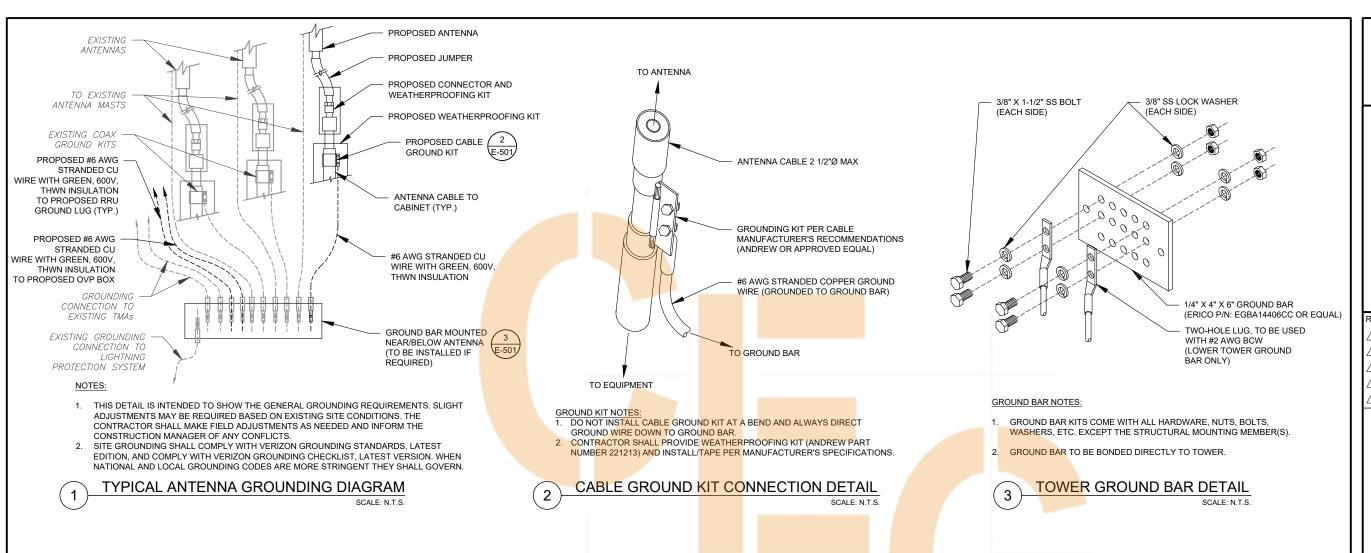

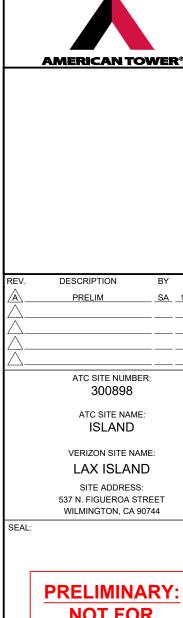

PRELIMINARY:
NOT FOR
CONSTRUCTION



|   |   | DATE DRAWN:  | 10/18/21   |
|---|---|--------------|------------|
|   | 1 | ATC JOB NO:  | 13716831   |
|   | 1 | CUSTOMER ID: | LAX ISLAND |
|   | 1 | CUSTOMER #:  | 124379     |
| ı |   |              |            |


GROUNDING DETAILS

SHEET NUMBER:

E-501

REVISION

DATE

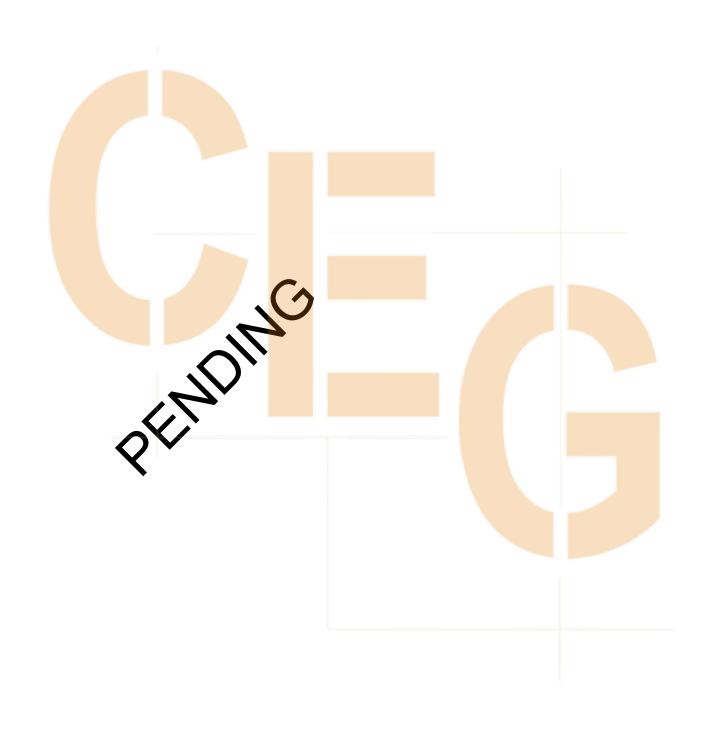

SUPPLEMENTAL

SHEET NUMBER:

REVISION:

R-601

MOUNT ANALYSIS

NOTE: THIS SHEET WAS CREATED BY OTHERS AND PROVIDED AT THE REQUEST OF THE CUSTOMER WITHOUT EDIT. PLEASE REFERENCE THE MOUNT ANALYSIS REPORT FOR COMPLETE MOUNT ANALYSIS CALCULATIONS AND DETAILS. SUPPLEMENTAL PAGES INCLUDED IN THE CONSTRUCTION DRAWINGS ARE FOR REFERENCE ONLY. GENERAL CONTRACTOR IS TO VERYIFY THEY HAVE THE MOST RECENT MOUNT ANALYSIS PRIOR TO CONTRUCTION.